MIXED USE DEVELOPMENT

MAXIMUM

MINIMUM

MICROWAVE

METAL

NEW

OVER

PLAM PLASTIC LAMINATE

PLYWOOD

PAINTED

RADICAL

REQUIRED

ROOM

RDWD REDWOOD

RUBBER BASE

SOLID CORE

SHEETING

SHEET

SIMILAR

SQUARE

STEEL

ST. STL STAINLESS STEEL

STORAGE

STRUCTURAL

SHEET VINYL

TOP OF CURB

TELEPHONE

TOP OF STEEL

TOP OF WALL

U.O.N. UNLESS OTHERWISE NOTED

VCT VINYL COMPOSITION TILE

WASHER AND DRYER

VERIFY IN FIELD

WATER CLOSET

WATER HEATER

WATERPROOF

TYPICAL

VERTICAL

WOOD

ROUGH OPENING

SEE STRUCTURAL DWGS

TONGUE AND GROOVE

REFRIGERATOR

OD

PLY.

PTD

RAD

SHT

SIM

SQ

S.S.D.

STL

STOR

STRL

TYP.

VERT.

V.I.F.

W/D

W/

WP

STV

MECHANICAL

MEDICINE CABINET

NOT IN CONTRACT

OVERFLOW DRAIN

OPPOSITE HAND

NOTTO SCALE

ON CENTER

170 SAN BRUNO AVENUE, SAN BRUNO, CA 94066



GLOSSARY

GLO	JAKI	
ABV. A.D. ADJ ACT AFF ALUM	ABOVE AREA DRAIN ADJACENT ACOUSTIC CEILING TILE ABOVE FINISH FLOOR ALUMINUM	MAX. MED MECH MIN. MTL MV
BLKG	BLOCKING	(N)
BLDG	BUILDING	N.I.C.
BD	BOARD	NTS
Q	CENTERLINE	O.C.
CLR	CLEAR	O/

CONC CONCRETE CONT CONTINUOUS CARPET

CPT **CERAMICTILE** DIMENSION DIMS. DIMENSIONS DOWN DWG DRAWING (E), EX. EXISTING

EXPANSION JOINT ELEC ELECTRIC EL., ELEV. ELEVATION **EMBEDDED** EQUAL **EXTERIOR**

FLOOR DRAIN FINISH FLOOR FLOOR FACE OF STUD FACE OF MASONRY GAUGE **GALV** GALVANIZED

GLASS GND GROUND GALVANIZED SHEET METAL T.O.W. GYP. BD. GYPSUM BOARD GWB GYPSUM WALLBOARD

HANDICAPPED HOLLOW METAL HOUSE PANEL INS. INSULATION

INSUL. INSULATION INT INTERIOR JAN JANITOR CLOSET KIT KITCHEN

LIGHT


LAV LAVATORY

SYMBOL LEGEND



ELEVATION KEY

SECTION KEY

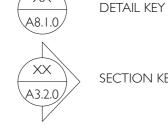

WALLTYPE KEY

DOOR NUMBER KEY



GENERAL NOTES

I.THESE DRAWINGS CONSTITUTE A PORTION OF THE CONTRACT DOCUMENTS AS DEFINED IN AIA DOCUMENT A201, THE GENERAL CONDITIONS OF THE CONTRACT FOR CONSTRUCTION. REFER TO PROJECT MANUAL.

2. IN BEGINNING WORK, CONTRACTOR ACKNOWLEDGES THOROUGH FAMILIARITY WITH THE BUILDING SITE CONDITIONS, WITH THE DRAWINGS AND SPECIFICATIONS, WITH THE DELIVERY FACILITIES AND ALL OTHER MATTERS AND CONDITIONS WHICH MAY AFFECT THE OPERATIONS AND COMPLETION OF THE WORK AND ASSUMES ALL RISK. CONTRACTOR TO VERIFY SURVEY DIMENSIONS BEFORE COMMENCING WORK, CONTRACTOR SHALL REPORT, AT ONCE, TO THE ARCHITECT ANY ERROR, INCONSISTENCY OR OMISSION THAT MAY BE DISCOVERED AND CORRECT AS DIRECTED, IN WRITING, BY THE ARCHITECT.

3. BY ACCEPTING AND USING THESE DRAWINGS, CONTRACTOR AGREES TO ASSUME SOLE AND COMPLETE RESPONSIBILITY FOR JOB SITE SAFETY CONDITIONS DURING THE COURSE OF CONSTRUCTION OF THIS PROJECT, INCLUDING SAFETY OF ALL PERSONS AND PROPERTY: THAT THIS REQUIREMENT SHALL APPLY CONTINUOUSLY AND NOT BE LIMITED TO NORMAL WORKING HOURS AND THAT THE CONTRACTOR SHALL DEFEND, INDEMNIFY AND HOLD THE OWNER AND THE ARCHITECT HARMLESS FROM ANY AND ALL LIABILITY, REAL OR ALLEGED, IN CONNECTION WITH THE PERFORMANCE OF THE WORK ON THIS PROJECT, EXCEPTING LIABILITY ARISING FROM THE SOLE NEGLIGENCE OF THE OWNER, THE ARCHITECT OR ANY UNAUTHORIZED PERSON ON THE SITE WITHOUT PERMISSION OF THE CONTRACTOR.

4. ARCHITECT AND OWNER WILL NOT BE RESPONSIBLE FOR ANY CHANGES IN PLANS, DETAILS OR SPECIFICATIONS UNLESS APPROVED IN WRITING IN ADVANCE OF CONSTRUCTION.

5. DO NOT SCALE DRAWINGS. WRITTEN DIMENSIONS SHALL HAVE PRECEDENCE OVER SCALED DIMENSIONS. CONTRACTOR SHALL VERIFY AND BE MADE COMPLETELY RESPONSIBLE FOR ALL DIMENSIONS AND CONDITIONS SHOWN AND A WRITTEN CHANGE ORDER REQUEST SHALL BE ISSUED BEFORE MAKING ANY CHANGES AT THE JOB SITE.

6. CONTRACTOR SHALL BE RESPONSIBLE FOR LOCATING ANY AND ALL EXISTING UNDERGROUND UTILITIES. ALL DAMAGE TO SUCH SHALL BE REPAIRED AT CONTRACTOR EXPENSE.

7. CONTRACTOR TO PROVIDE BRACING AND SUPPORT AS REQUIRED TO MAINTAIN THE INTEGRITY AND SAFETY OF THE EXISTING STRUCTURE AND ADJACENT STRUCTURE(S) AS

8. ALL DIMENSIONS ARE TO FACE OF STUD, FACE OF CMU OR CENTERLINE OF STEEL, UNLESS OTHERWISE NOTED.

9. ALL EXISTING WALLS. FLOORS AND CEILING AT REMOVED. NEW OR MODIFIED CONSTRUCTION SHALL BE PATCHED AS REQUIRED TO MAKE SURFACES WHOLE, SOUND AND TO MATCH EXISTING ADJACENT CONSTRUCTION, EXCEPT AS OTHERWISE NOTED.

10. ALL WORK SHALL BE IN ACCORDANCE WITH ALL FEDERAL, STATE AND LOCAL BUILDING CODES AND SAFETY ORDINANCES IN EFFECT AT THE PLACE OF BUILDING.

I I. ALL DRAWINGS, SPECIFICATIONS AND COPIES THEREOF FURNISHED BY THE ARCHITECT ARE COPYRIGHTED DOCUMENTS AND SHALL REMAIN THE PROPERTY OF ELEVATION ARCHITECTS. THESE DOCUMENTS ARE THE INSTRUMENTS OF SERVICE AND AS SUCH, SHALL REMAIN THE PROPERTY OF ELEVATION ARCHITECTS WHETHER THE PROJECT FOR WHICH THEY ARE INTENDED IS EXECUTED OR NOT. THESE DOCUMENTS SHALL NOT BE USED BY ANYONE FOR OTHER PROJECTS, ADDITIONS TO THIS PROJECT OR FOR COMPLETION OF THIS PROJECT BY OTHERS EXCEPT AS AGREED IN WRITING BY ELEVATION ARCHITECTS AND WITH APPROPRIATE COMPENSATION.

SUBMISSION OR DISTRIBUTION TO MEET OFFICIAL REGULATORY REQUIREMENTS OR FOR OTHER PURPOSES IN CONNECTION WITH THE PROJECT IS NOT TO BE CONSTRUED AS PUBLICATION IN DEROGATION OF THE ARCHITECT'S COMMON LAW COPYRIGHT OR OTHER RESERVED RIGHTS.

12.THE CONTRACTOR SHALL TAKE APPROPRIATE STEPS THROUGHOUT THE EXECUTION OF THE PROJECT TO PREVENT AIRBORNE DUST DUETO THE WORK. MAINTAIN WORK AREAS CLEAN AND FREE FROM UNDUE ENCUMBRANCES AND REMOVE SURPLUS MATERIALS AND WASTE AS THE WORK PROGRESSES.

13. IT IS THE INTENT OF THESE DOCUMENTS TO FULLY COMPLY WITH THE AMERICANS WITH DISABILITIES ACT (ADA) AND TITLE 24 OF THE CALIFORNIA CODE OF REGULATIONS. WHERE A REQUIREMENT IS IN CONFLICT, THE MORE STRINGENT REQUIREMENT SHALL GOVERN. WHERE DIMENSIONS, SLOPE GRADIENTS AND OTHER CRITICAL CRITERIA ARE NOTED, THEY ARE TO BE ADHERED TO EXACTLY, UNLESS NOTED AS APPROXIMATE. CONTRACTOR'S FAILURE TO COMPLY WITH ANY PROVISION DESCRIBED IN THE DRAWINGS AND SPECIFICATIONS RELATED TO THESE ACCESSIBILITY LAWS AND CODES WILL REQUIRE CORRECTION, AT CONTRACTOR'S EXPENSE. WHERE MAXIMUM DIMENSIONS AND SLOPE GRADIENTS ARE NOTED, NO EXCEPTION WILL BE MADE FOR EXCEEDING THESE REQUIREMENTS.

PLANNING DEPARTMENT NOTES

170 SAN BRUNO AVE. APN: 02011 1160 LOT AREA: 12,478 SF **ZONING:** TOD-I (SAN BRUNO AVE) 65'-0" HEIGHT: F.A.R.:

SETBACKS:

5' MIN - 10' AVERAGE REAR: SIDE:

STEPBACKS:

STREET SIDE:

FACING SAN BRUNO AVE.: 15' ABOVE 3RD STORY

ADJACENT TO R-I & R-2 DISTRICTS:

15' ABOVE 3RD STORY

ALLOWABLE BUILDING AREA:

F.A.R. = 2: 12,478 X 2 = **24,956 SF** (BEFORE DENSITY BONUS

CA DENSITY BONUS LAW: (AB-2345)

50% RESIDENTIAL INCREASE WITH 15% DEDICATED VERY LOW INCOME

970 SF PROPOSED COMMERCIAL AREA: 23,842 SF REMAINING RESIDENTIAL: BONUS INCREASE (50%): 11,921 SF

TOTAL ALLOWABLE RESIDENTIAL: 35,763 SF TOTAL ALLOWABLE BUILDING AREA: 36.877 SF

PROPOSED BUILDING AREA: BASEMENT (GARAGE) 10,188 GSF (NOT COUNTED)

IST FLOOR: 2ND FLOOR: 4,674 GSF 3RD FLOOR: 6,273 GSF 4TH FLOOR: 6,064 GSF 5TH FLOOR: 6,064 GSF 6TH FLOOF TOTAL: 36,569 GSF

RESIDENTIAL UNITS:

TOTAL UNITS: 42 SAN BRUNO REQUIRED BMR: 15% TOTAL (5% VERY-LOW, 5% LOW, 5% MODERATE) 15% VERY LOW (42 X 15% = 6 UNITS)

UNIT MIX: STUDIO: I UNIT I BEDROOM: 37 UNITS

2 BEDROOM: 4 UNITS

PARKING:

REQUIRED PARKING: I SPACE / STUDIO & I-BEDROOM = 38 SPACES 2 SPACES / 2+ BEDROOM UNITS= 8 SPACES I SPACE / 10 UNITS (GUEST)= 4 SPACES I SPACE / 300 SF RETAIL= 4 SPACES

TOTAL REQUIRED SPACES: 54 SPACES

PROVIDED SPACES: 36 UNDERGROUND PARKING SPACES:

17 IN TRI-LEVEL STACKER

17 STANDARD SPACES

2 HANDICAPVAN LOCATION

OPEN SPACE

REQUIRED TOTAL OPEN SPACE: 40 SF X 42 = 1,680 SF PROVIDED PUBLIC OPEN SPACE: 2,318 SF PROVIDED PRIVATE OPEN SPACE: 2,581 SF TOTAL PROVIDED OPEN SPACE: 4,899 SF

BICYCLE PARKING

I CLASS I SPACE / UNIT: 42 CLASS I SPACES 4.2 CLASS II SPACES I CLASS II SPACES / 10 UNITS: 1.5 SPACES / 3,000 SF RETAIL: 1.5 CLASS II SPACES

TOTAL CLASS | SPACES: 42 CLASS I SPACES TOTAL CLASS II SPACES: 6 CLASS II SPACES

PROVIDED: CLASS | SPACES: CLASS II SPACES:

42 CLASS I SPACES 6 CLASS II SPACES

PERMITS

- TRANSIT CORRIDOR PRE-APPLICATION - BUILDING PERMIT

APPLICABLE CODES

2019 CALIFORNIA BUILDING CODE (CBC) 2019 CALIFORNIA MECHANICAL CODE (CMC) 2019 CALIFORNIA PLUMBING CODE (CPC) 2019 CALIFORNIA ELECTRICAL CODE (CEC) 2019 CALIFORNIA FIRE CODE (CFC) w/ CITY OF SAN BRUNO AMENDMENTS **CURRENT NFPA 13** 2019 CALIFORNIA ENERGY CODE

SCOPE OF WORK:

NEW 6-STORY RESIDENTIAL BUILDING WILL INCLUDE 42 RESIDENTIAL UNITS WITH STREET LEVEL COMMERCIAL.

- BASEMENT INCLUDES 43 VEHICLE PARKING SPACES, BICYCLE PARKING/REPAIR, STORAGE & UTILITES.

- IST FLOOR INCLUDES 1,205 GSF COMMERCIAL LEASE SPACE, AND RESIDENTIAL LOBBY AND SHARED COMMUNITY ROOM, 3 RESIDENTIAL LOFT UNITS, RESIDENTIAL SUPPORT, ELECTRICAL & RISER ROOMS.

- FLOORS 2 TO 6 INCLUDE RESIDENTIAL UNITS

BUILDING DEPARTMENT NOTES

PROPOSED BUILDING USE: GARAGE, BIKE STORAGE & UTILITIES COMMERCIAL & RESIDENTIAL

2ND THRU 6TH FL: RESIDENTIAL SOLAR PANELS ENTIRE BUILDING TO BE EQUIPPED WITH APPROVED

AUTOMATIC SPRINKLER SYSTEM PER NFPA 13.

OCCUPANCY CLASSIFICATION: PARKING GARAGE: S-2 COMMERCIAL: B RESIDENTIAL: R-2

OCCUPANCY SEPARATION: **VERTICAL SHAFTS: 2-HOUR** IST FLOOR: I-HOUR RESIDENTIAL I-HOUR

Residential Units

4,973|sf

4,973 sf

5,175|sf

3,706|sf

2,695 sf

26,495 sf

6th FLOOR

5th FLOOR

4th FLOOR

3rd FLOOR

2nd FLOOR

1st FLOOR

CONSTRUCTION CLASSIFICATION: FIRST FLOOR : TYPE: I-A SECOND - SIXTH FLOOR: TYPE 3-A

EXITING REQUIREMENTS: 2 MEANS OF EGRESS

PROJECT TEAM

Building Owner: Double AA Corporation 1435 Huntington Ave. South San Francisco, CA 94080 Contact: Wisfe Aish 650.589.7722 Email: wisfe@doubleaacorp.com

Architect: Elevation Architects 439 Healdsburg Avenue San Francisco, CA 94109 Contact: Jonathan Pearlman 415.537.1125 ×101 jonathan@elevationarchitects.com

TABLE OF CONTENTS

A-0.1	COVER SHEET
C-I	SURVEY
A-1.1 A-1.2	EXISTING SITE PLAN PROPOSED SITE PLAN
A-2.0 A-2.1 A-2.2 A-2.3 A-2.4 A-2.5 A-2.6 A-2.7	BASEMENT FLOOR PLAN 1ST FLOOR PLAN 2ND FLOOR PLAN 3RD FLOOR PLAN 4TH FLOOR PLAN 5TH FLOOR PLAN 6TH FLOOR PLAN ROOF PLAN
A-3.1	WEST AND SOUTH ELEVA

A-3.2 EAST AND NORTH ELEVATIONS A-3.3 BUILDING SECTIONS A-3.4 3D RENDERING A-3.5 3D RENDERING A-3.6 3D RENDERING

Unit 601 | Unit 602 | Unit 603 | Unit 604 | Unit 605 | Unit 606 | Unit 606 | Unit 607

578

I-bdrm | I-b

I-bdrm I-bdrm I-bdrm I-bdrm I-bdrm I-bdrm

I-bdrm | I-b

525

4,509 3,847 3,625 2,837 2,653 2,814 2,104

578

578

525

525

Unit 201 | Unit 202 | Unit 203 | Unit 204 | Unit 205 | Unit 206 |

560

965

Unit 101 Unit 102 Unit 103

865

I-bdrm | I-bdrm | I-bdrm |

865

I-bdrm I-bdrm I-bdrm I-bdrm I-bdrm

I-bdrm I-bdrm I-bdrm I-bdrm I-bdrm I-bdrm 2-bdrm

Unit 50 | Unit 502 | Unit 503 | Unit 504 | Unit 505 | Unit 506 | Unit 507 | Unit 508

Unit 40 | Unit 402 | Unit 403 | Unit 404 | Unit 405 | Unit 406 | Unit 407 | Unit 408

536

536

536

498

547 710

Unit 30 | Unit 302| Unit 303| Unit 304| Unit 305| Unit 306| Unit 307| Unit 308| Unit 30

PMEN⁻

ELEVATION architects

439 Healdsburg Avenue Healdsburg, CA 95448

415.537.1125 (San Francisco) :v 707.433.2509 (Healdsburg) :v

www.elevationarchitects.com :w

USE MIXED
170 San E
San Brune

Cover Sheet

Studio 2-bdrn

344

3,206




checked by: date: 4.26.22

21.07

JP, KC


NOT FOR CONSTRUCTION

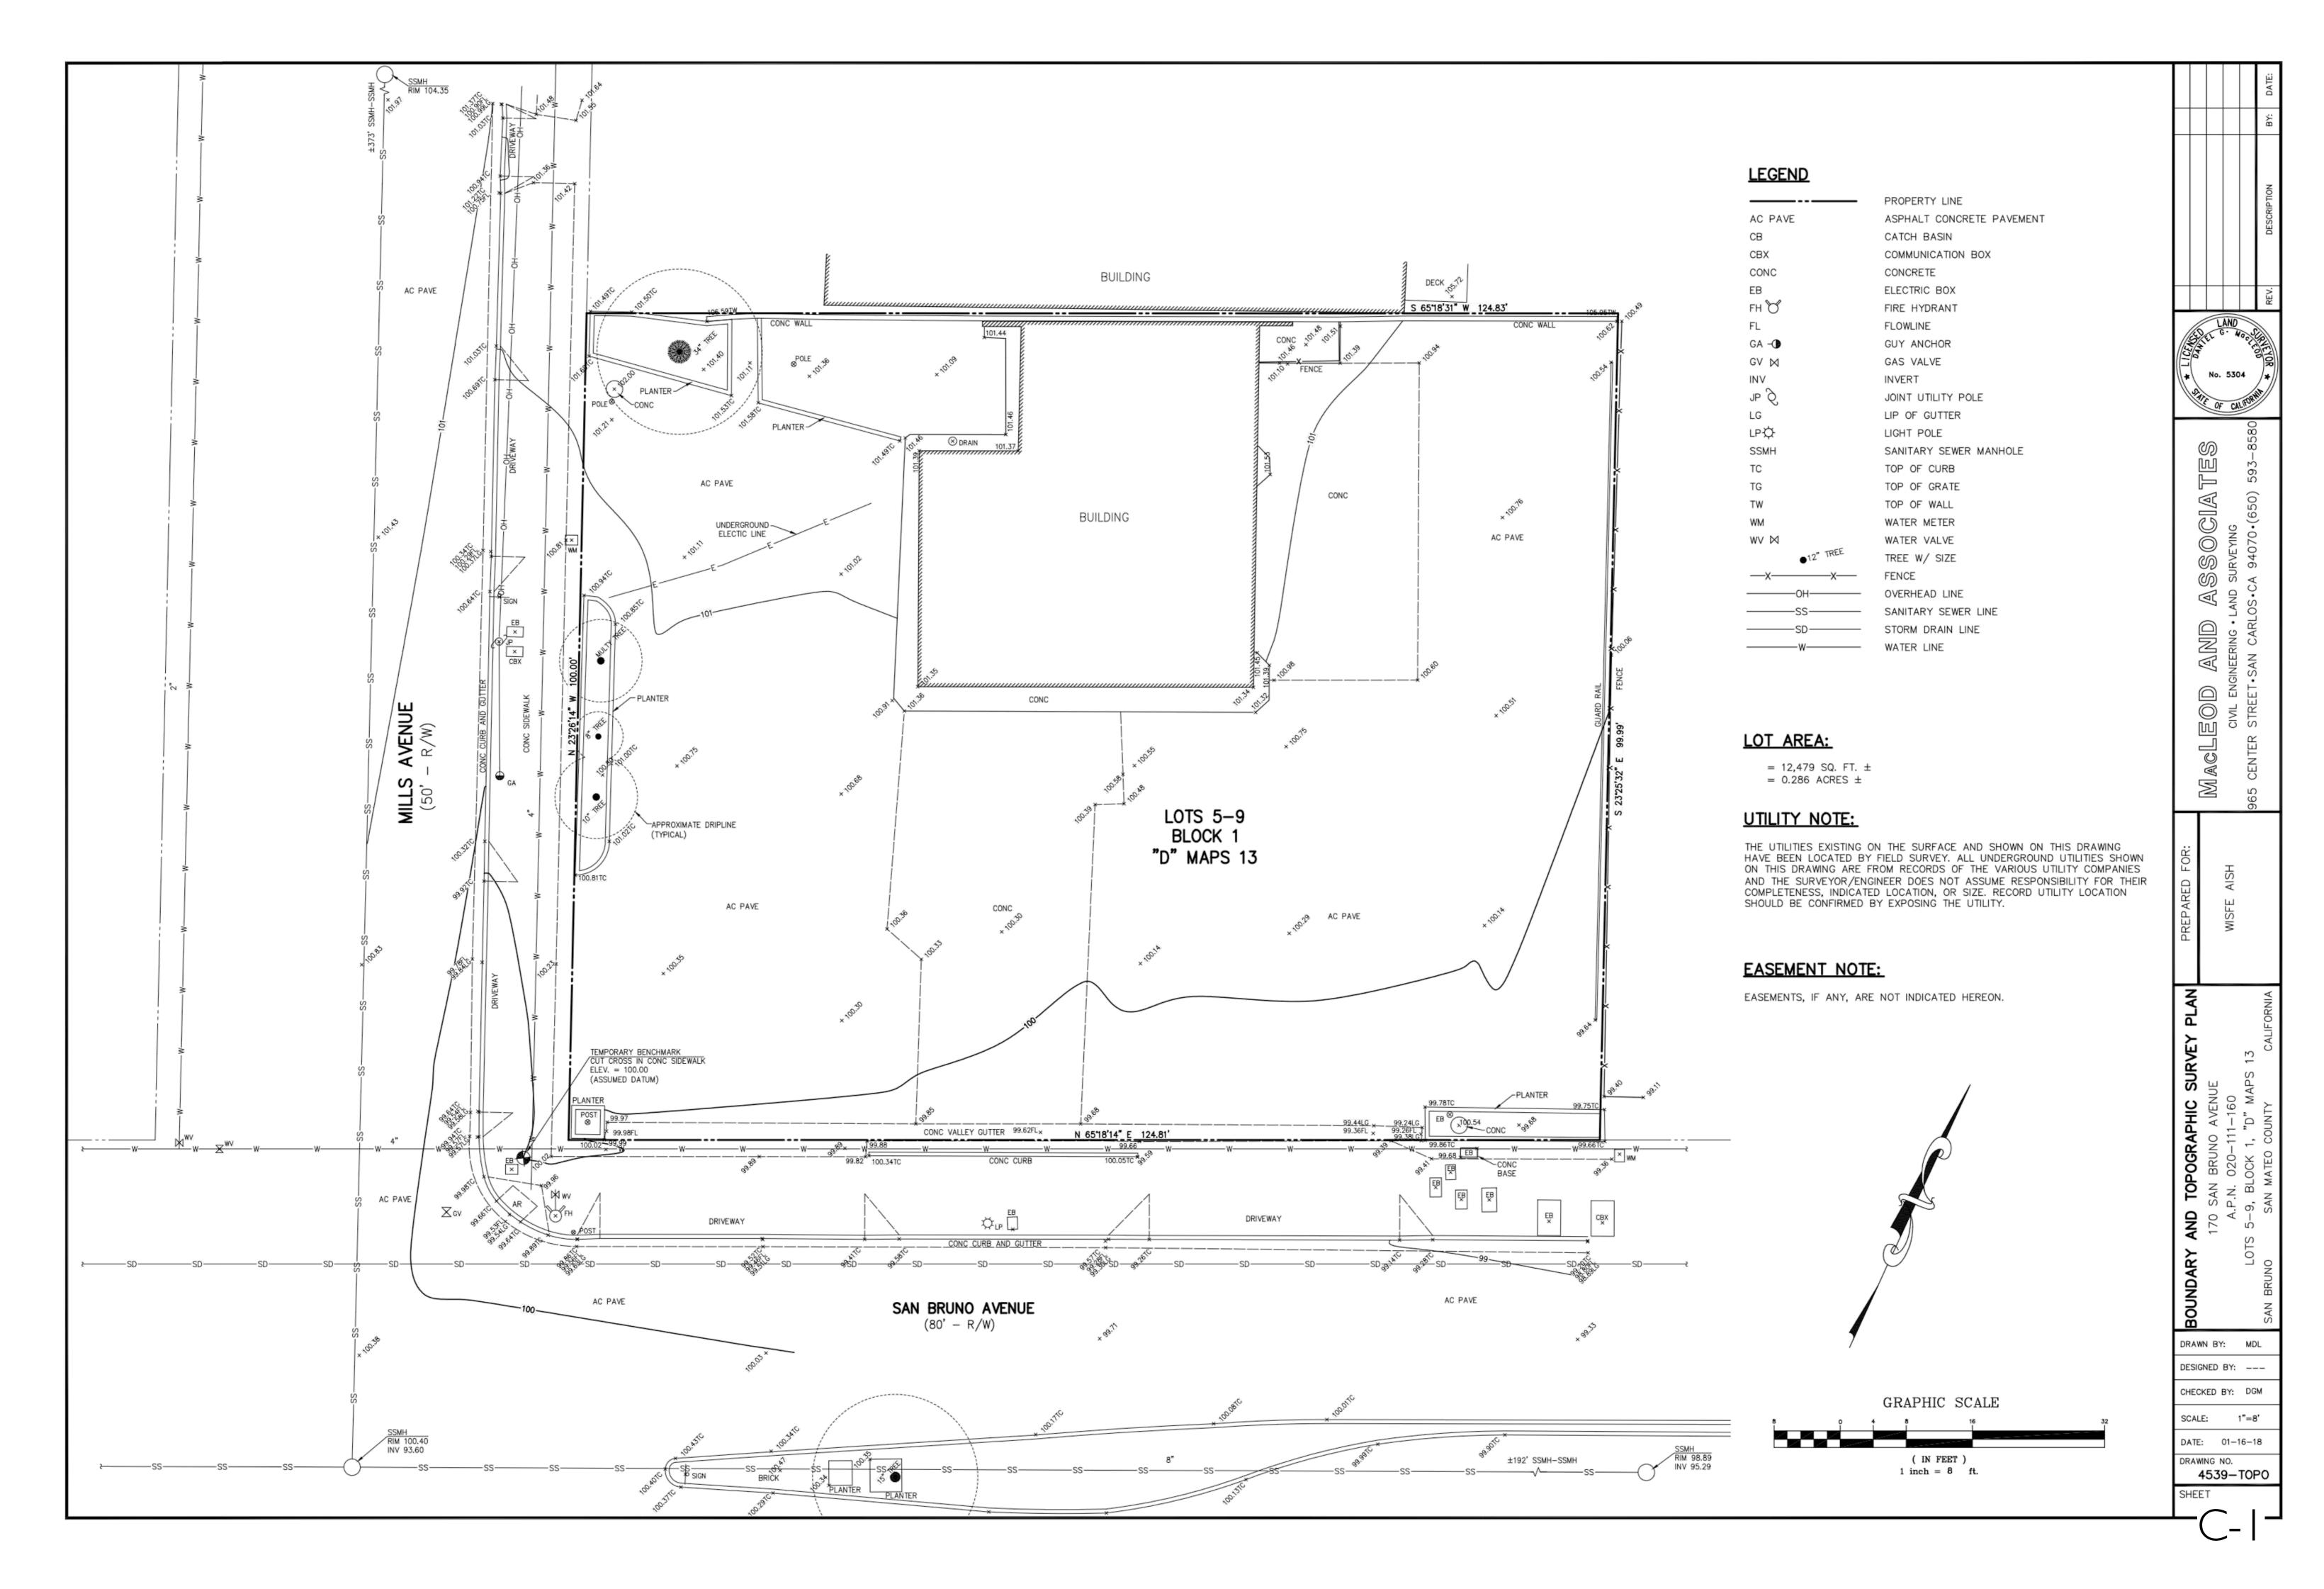



439 Healdsburg Avenue Healdsburg, CA 95448 415.537.1125 (San Francisco) :v 707.433.2509 (Healdsburg) :v www.elevationarchitects.com :w



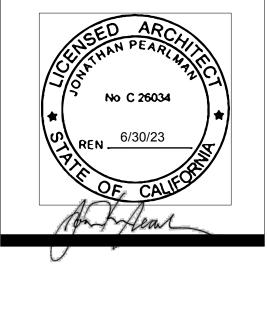

#	date	issue	

Existing Site Plan


project:	21.07
drawn by:	JP, KC
checked by:	JP
date:	4.26.22
scale:	








415.537.1125 (San Francisco) :v 707.433.2509 (Healdsburg) :v www.elevationarchitects.com :w

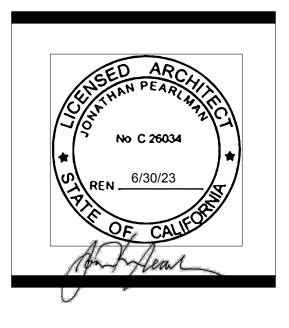


#	date	issue	
			-
			-
			-
			-
			-
			-

Proposed Site Plan

project:	21.07
drawn by:	JP, KC
checked by:	JP
date:	4.26.22
scale:	

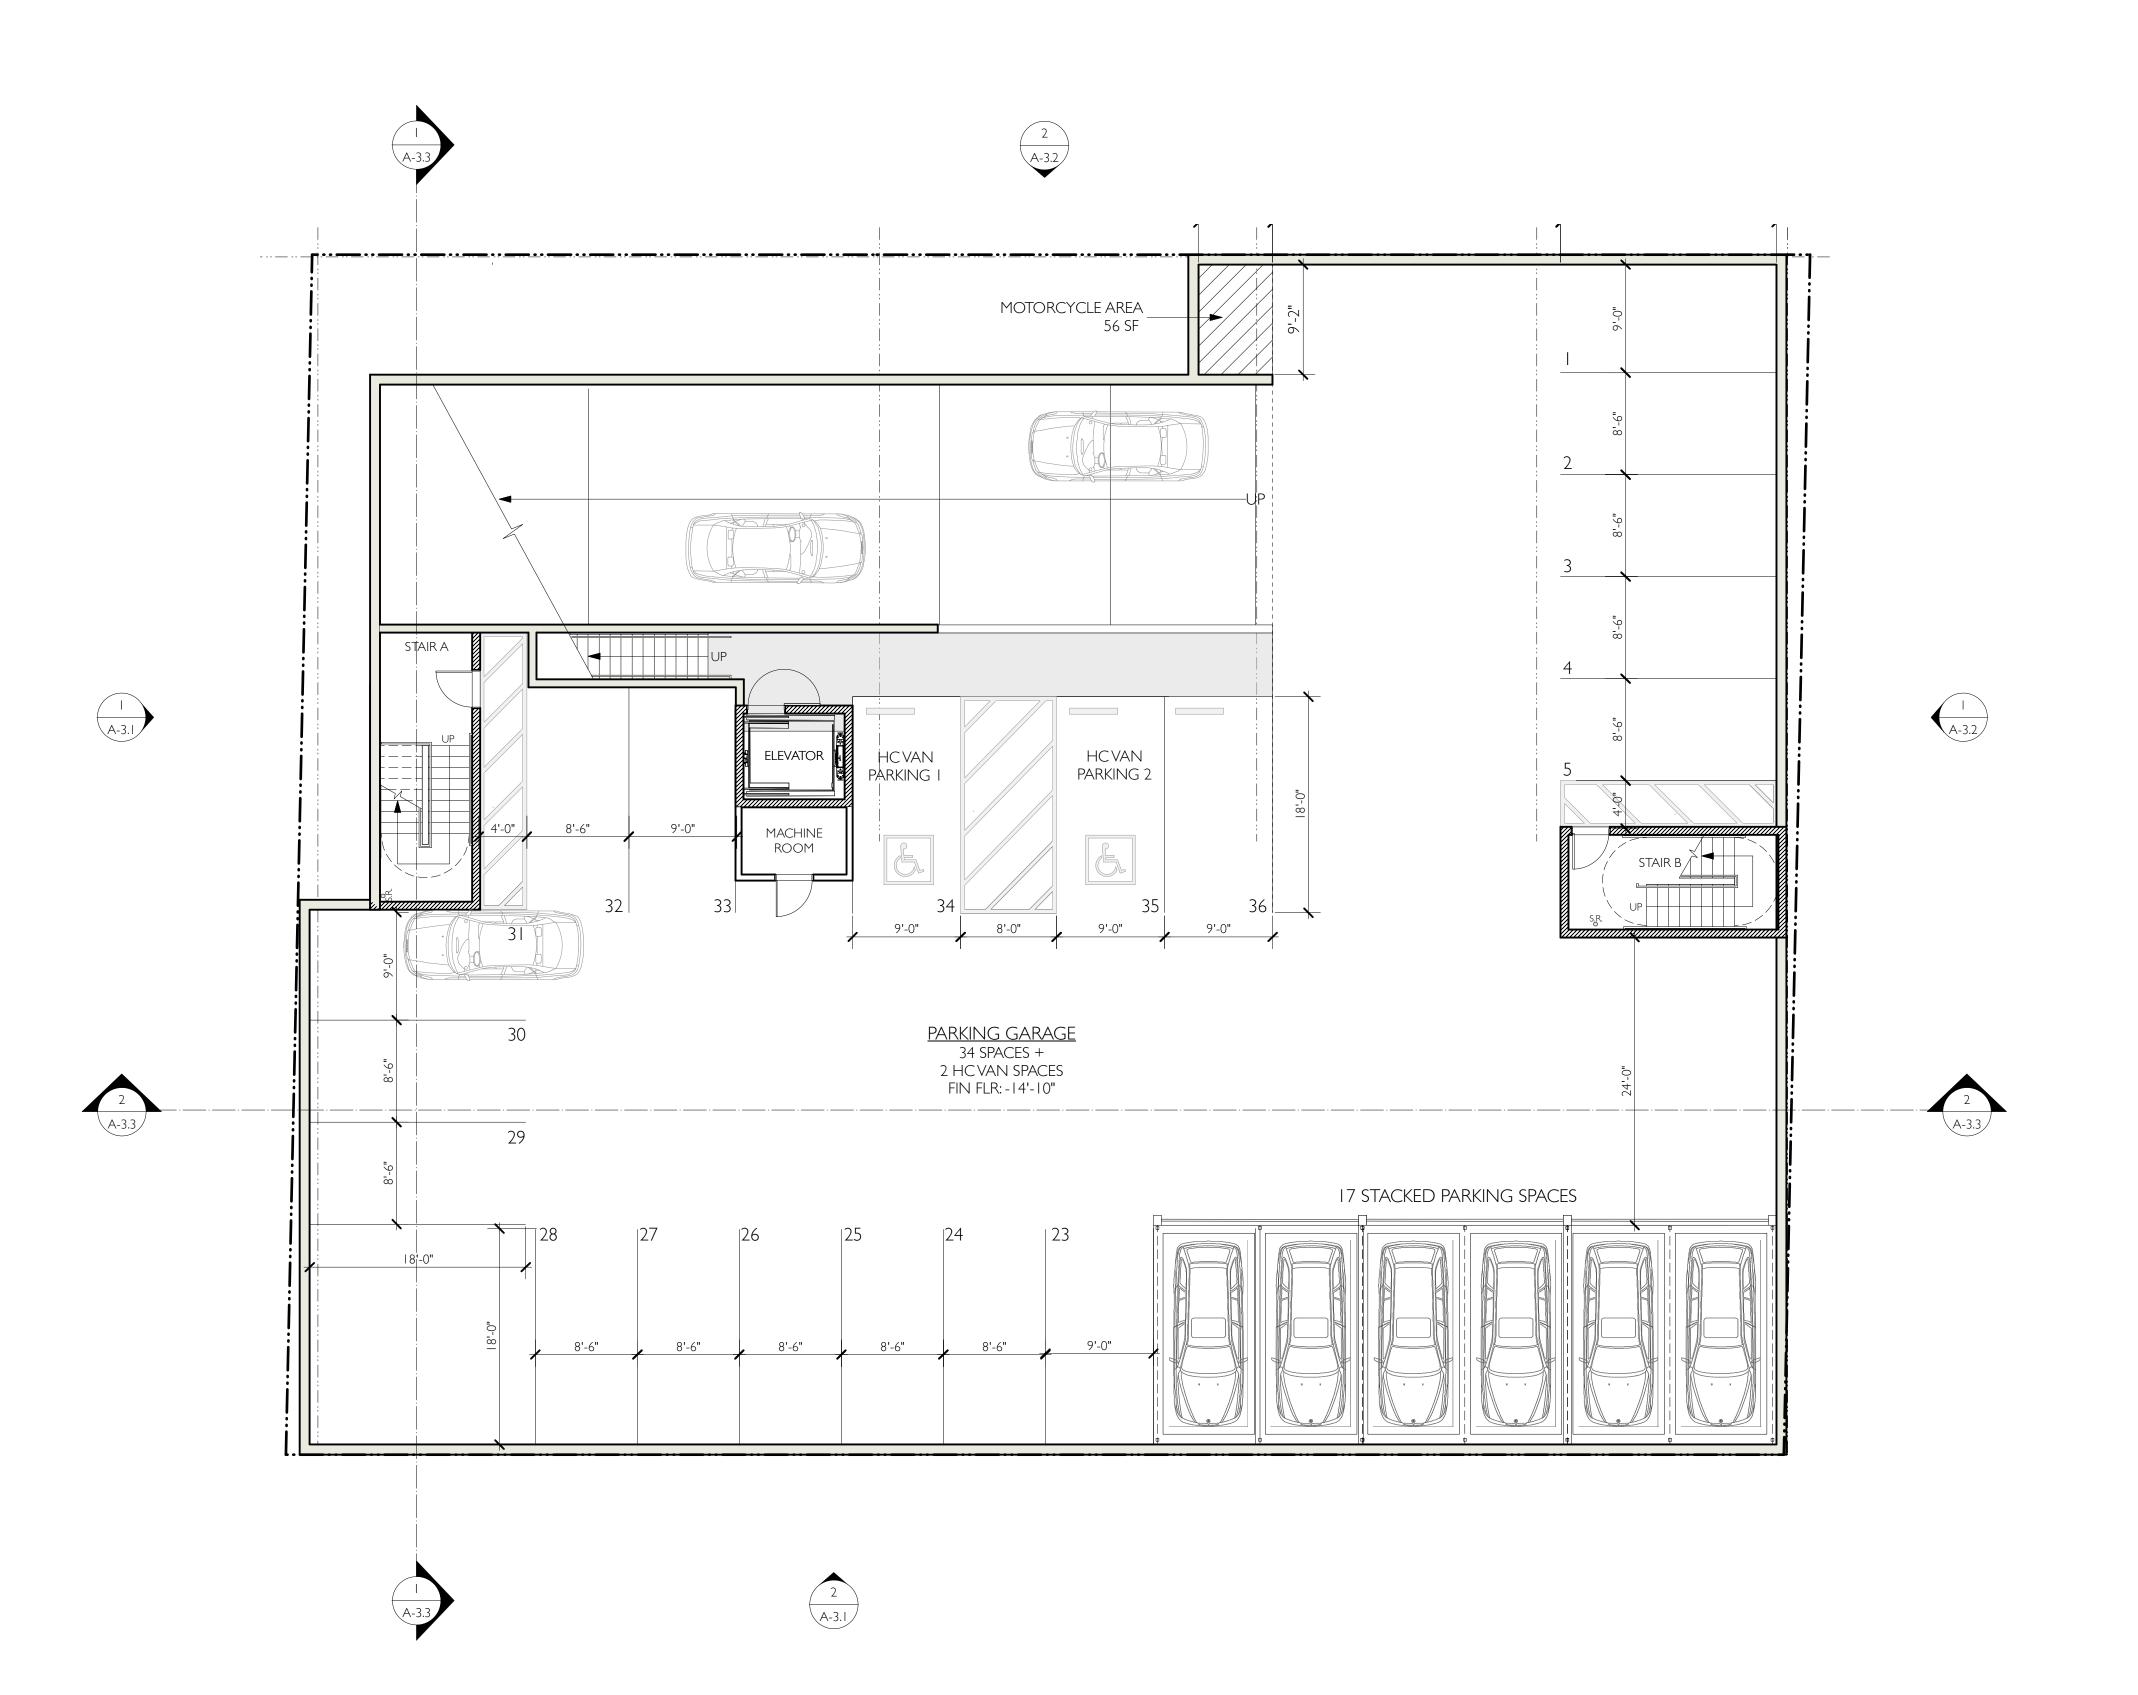


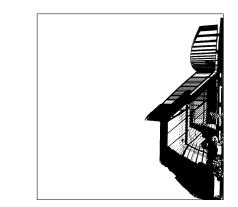

ELEVATION architects

439 Healdsburg Avenue Healdsburg, CA 95448

415.537.1125 (San Francisco) :V 707.433.2509 (Healdsburg) :V www.elevationarchitects.com :W

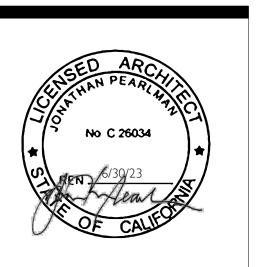

MIXED-USE DEVELOPMENT
170 SAN BRUNO AVE
SAN BRUNO, CA 94066

Basement Floor Plan

21.07 drawn by: checked by: 4.26.22 date: 1/4" = 1'-0"

2 - BEDROOM

BASEMENT FLOOR PLAN
- Scale: 1/8" = 1'-0"


UNIT KEY

I - BEDROOM

STUDIO

WALLTYPES


I HOUR RATED WALL

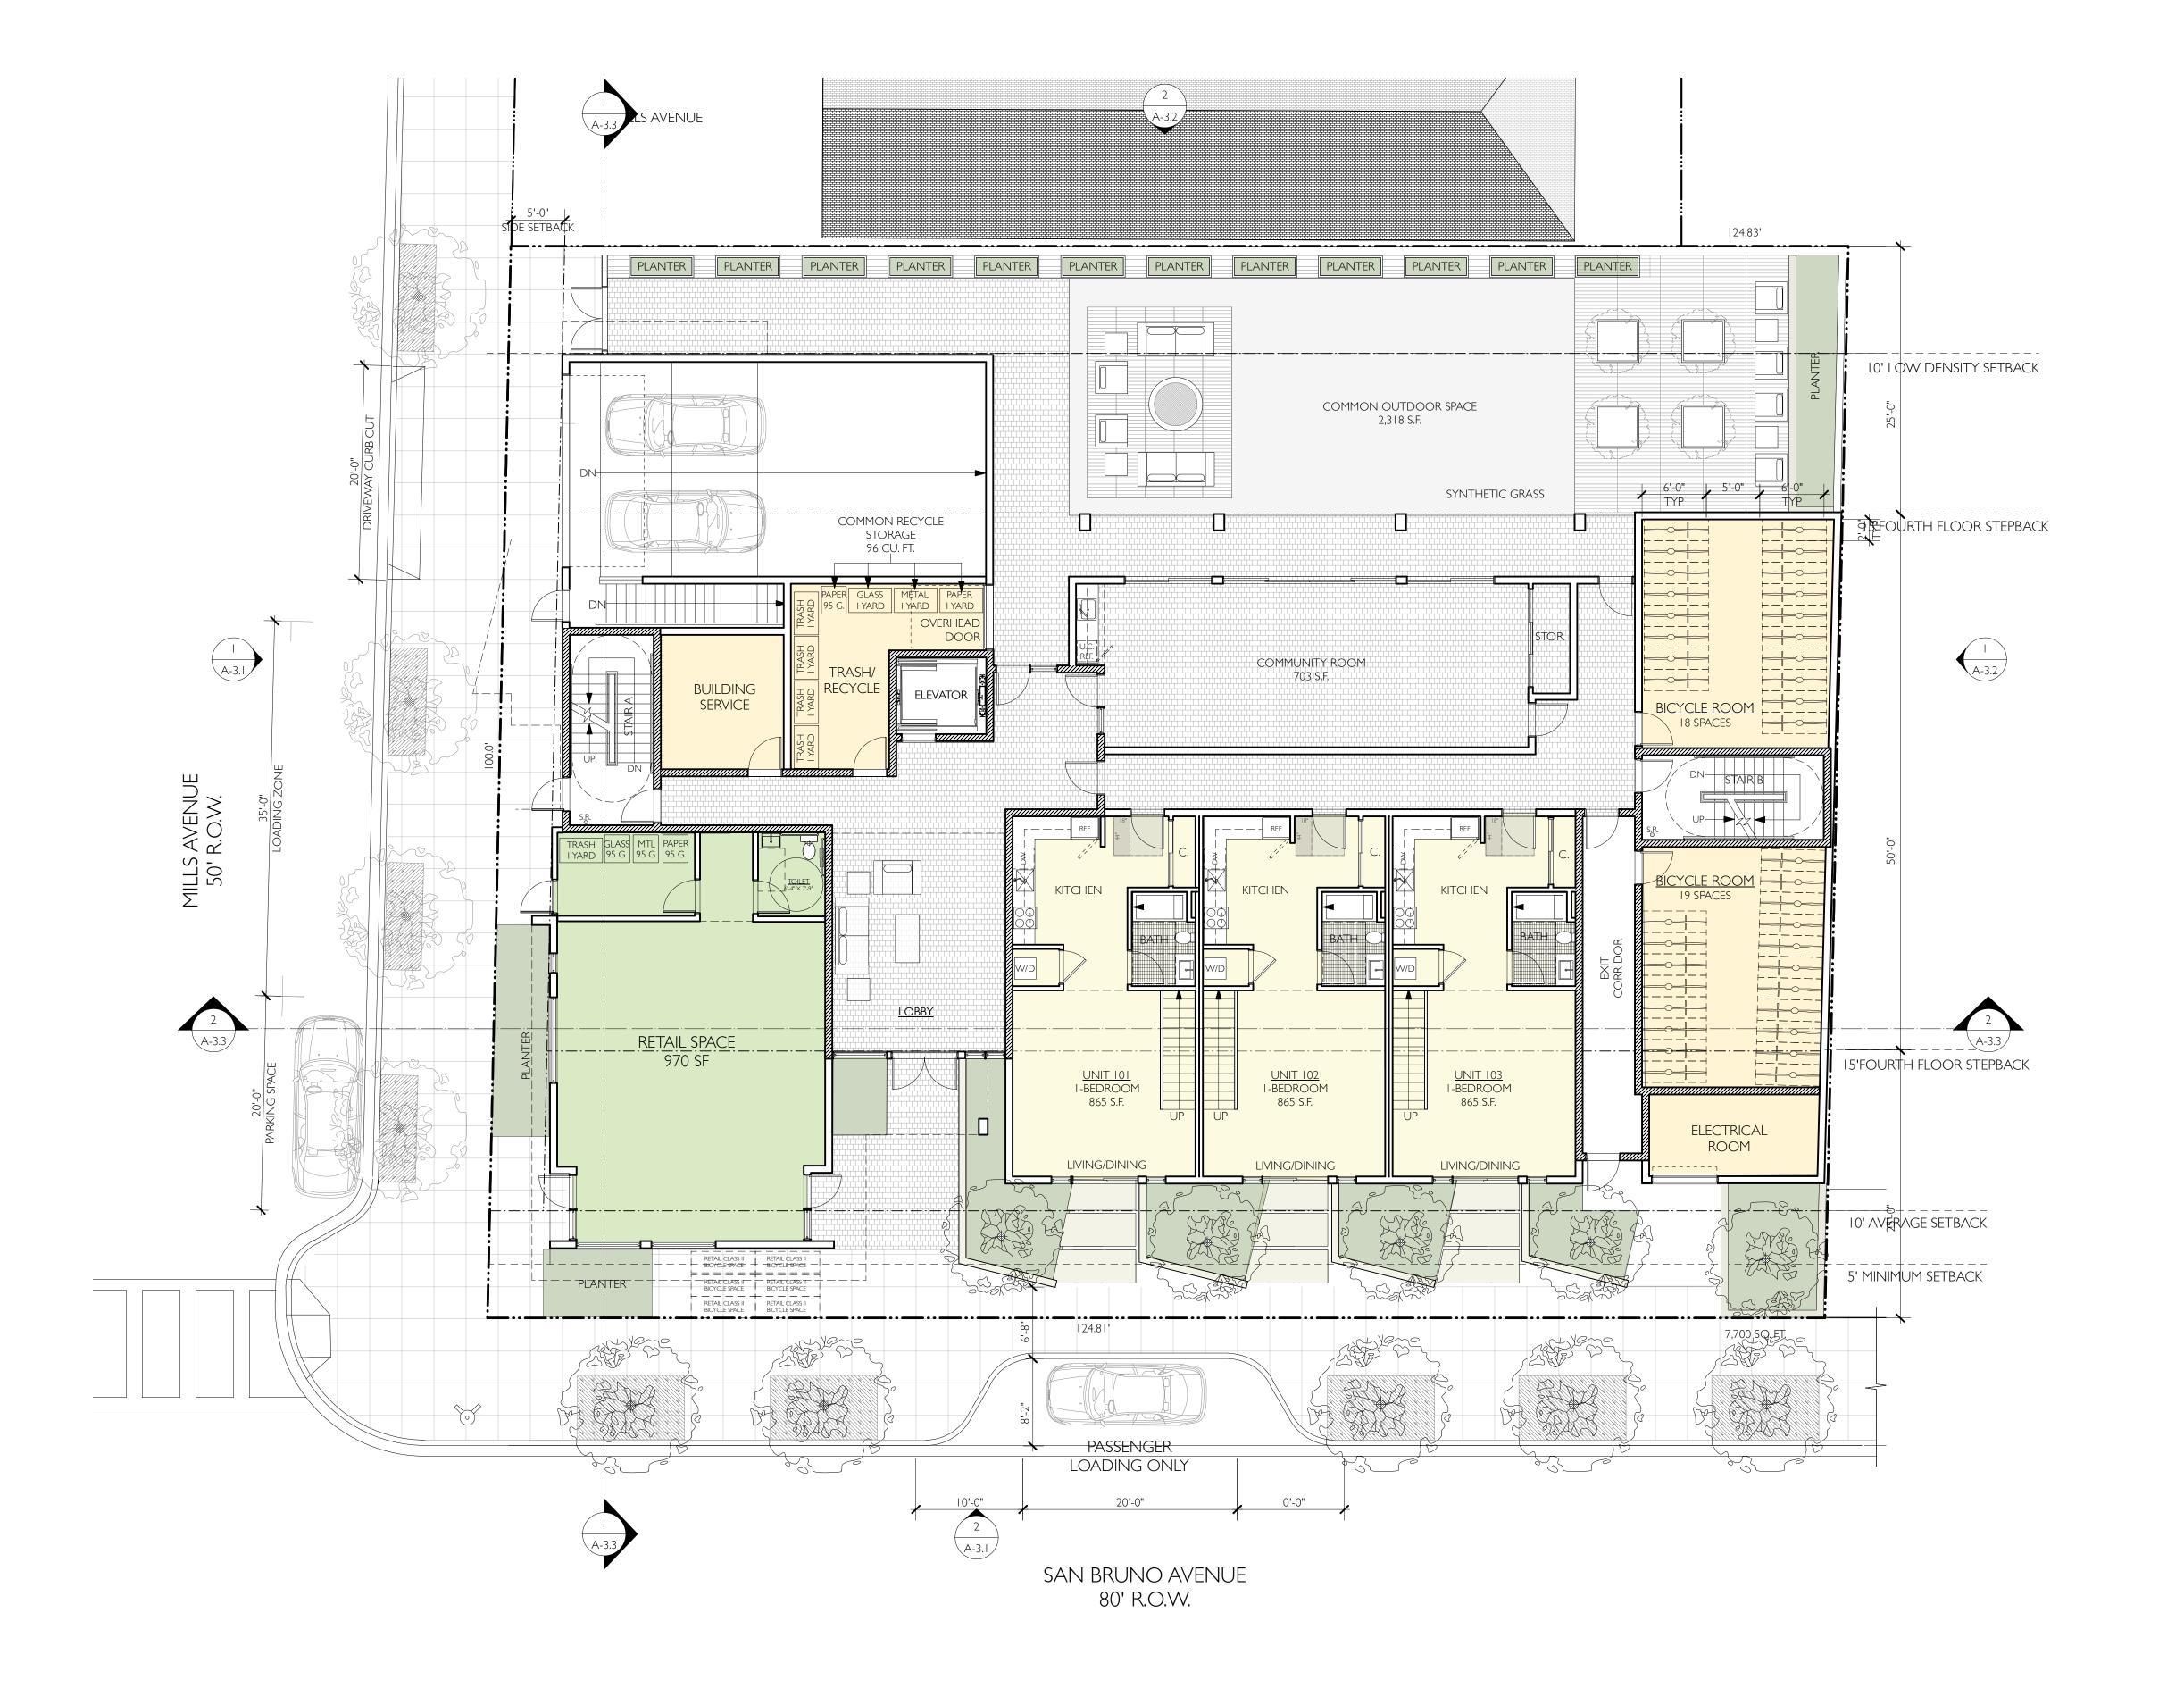



ELEVATION architects

415.537.1125 (San Francisco) :v 707.433.2509 (Healdsburg) :v www.elevationarchitects.com :w

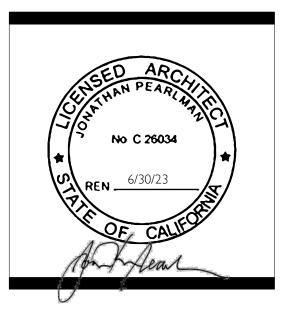

MIXED-USE DEVELOPMENT
170 SAN BRUNO AVENUE
SAN BRUNO, CA 94066

#	date	issue	

First Floor Plan

project:	21.07
drawn by:	kc
checked by:	JP
date:	4.26.22
scale:	1/4" = 1'-0"

A-2.1

I ST FLOOR PLAN
- Scale: 1/8" = 1'-0"

S C A L E 1/8" = 1'-0"

| 0 | 2' | 4' | 8' | 16'

WALLTYPES

I HOUR RATED WALL

2 HOUR RATED WALL

UNIT KEY

STUDIO


I - BEDROOM





ELEVATION architects

415.537.1125 (San Francisco) :v 707.433.2509 (Healdsburg) :v www.elevationarchitects.com :w

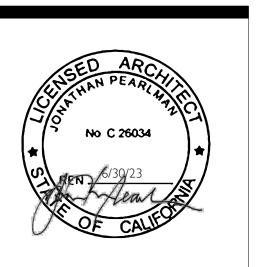

MIXED-USE DEVELOPMENT
170 SAN BRUNO AVENUE
SAN BRUNO, CA 94066

#	date	issue

2nd Floor Plan

project:	21.07
drawn by:	kc
checked by:	JP
date:	4.26.22
scale:	1/4" = 1'-0"

UNIT KEY

STUDIO

I - BEDROOM

2 - BEDROOM


WALLTYPES

I HOUR RATED WALL



ELEVATION architects

415.537.1125 (San Francisco) : V 707.433.2509 (Healdsburg) : V www.elevationarchitects.com : W

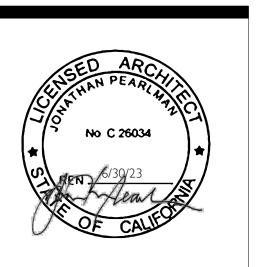

MIXED-USE DEVELOPMENT
170 SAN BRUNO, CA 94066

date issue

Third Floor Plan

project:	21.07
drawn by:	kc
checked by:	JP
date:	4.26.22
scale:	1/4" = 1'-0"

2 - BEDROOM

S C A L E 1/8" = 1'-0"

0 | 2' | 4' | 8' | | 16' |

UNIT KEY

I - BEDROOM

WALLTYPES

I HOUR RATED WALL

2 HOUR RATED WALL

3RD FLOOR PLAN
- Scale: 1/8" = 1'-0"


ale: 1/8" = 1'-0"





ELEVATION architects

415.537.1125 (San Francisco) :v 707.433.2509 (Healdsburg) :v www.elevationarchitects.com :w

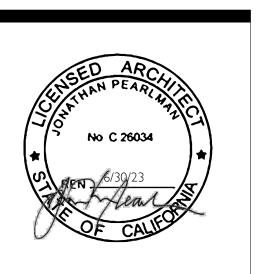

MIXED-USE DEVELOPMENT
170 SAN BRUNO AVENUE
SAN BRUNO, CA 94066

Fourth Floor Plan

project:	21.07
drawn by:	ko
checked by:	JF
date:	4.26.22
scale:	1/4" = 1'-0'
-	

2 - BEDROOM

S C A L E 1/8" = 1'-0"

0 | 2' | 4' | 8' | 16'

UNIT KEY

STUDIO

I - BEDROOM


WALLTYPES

I HOUR RATED WALL



ELEVATION architects

415.537.1125 (San Francisco) :v 707.433.2509 (Healdsburg) :v www.elevationarchitects.com :w

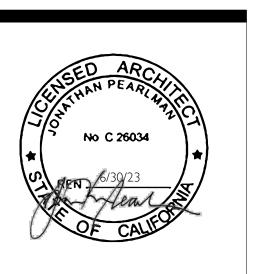

MIXED-USE DEVELOPMENT
170 SAN BRUNO AVENUE
SAN BRUNO, CA 94066

Fifth Floor Plan

 project:
 21.07

 drawn by:
 kc

 checked by:
 JP

 date:
 4.26.22

 scale:
 I/4" = I'-0"

2 - BEDROOM

S C A L E 1/8" = 1'-0"

0 2' 4' 8' | 16'

UNIT KEY

STUDIO

I - BEDROOM

WALLTYPES


I HOUR RATED WALL





ELEVATION architects

415.537.1125 (San Francisco) :V 707.433.2509 (Healdsburg) :V www.elevationarchitects.com :W

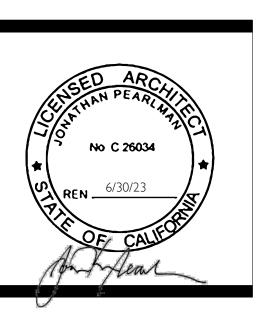

MIXED-USE DEVELOPMENT 170 SAN BRUNO AVENUE SAN BRUNO, CA 94066

date issue

Sixth Floor Plan

project:	21.07
drawn by:	ko
checked by:	JF
date:	4.26.22
scale:	1/4" = 1'-0'
-	

S C A L E 1/8" = 1'-0"
|0 |2' |4' |8' |16'


UNIT KEY

I - BEDROOM

2 - BEDROOM


WALLTYPES

I HOUR RATED WALL

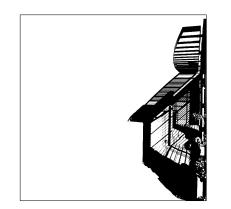

ELEVATION architects

415.537.1125 (San Francisco) :v 707.433.2509 (Healdsburg) :v www.elevationarchitects.com :w

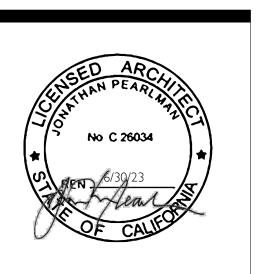

MIXED-USE DEVELOPMENT
170 SAN BRUNO AVENUE
SAN BRUNO, CA 94066

date issue

Roof Plan

project:	21.07
drawn by:	ko
checked by:	JF
date:	4.26.22
scale:	1/4" = 1'-0'

A-2.7

WALL TYPES

I HOUR RATED WALL
2 HOUR RATED WALL
OR PLAN

VALL TYPES


UNIT KEY

1 - BEDROOM
2 - BEDROOM
2 - BEDROOM





415.537.1125 (San Francisco) :v 707.433.2509 (Healdsburg) :v www.elevationarchitects.com :w

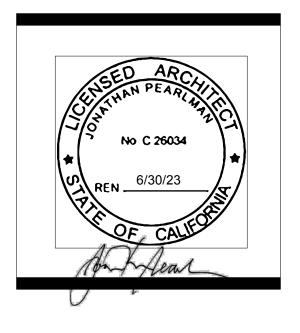

MIXED USE DEVELOPMENT
170 SAN BRUNO AVENUE
SAN BRUNO, CA 94066

Elevations

date issue

project:	21.07
drawn by:	JP, KC
checked by:	JP
date:	4.26.22
scale:	





Healdsburg, CA 95448

415.537.1125 (San Francisco) :v 707.433.2509 (Healdsburg) :v

www.elevationarchitects.com :w

REN ____6/30/23

MIXED USE DEVELOPMENT
170 SAN BRUNO AVENUE
SAN BRUNO, CA 94066


Elevations	
LIEVALIONS	

date issue

project:	21.07
drawn by:	JP, KC
checked by:	JP
date:	4.26.22


A-3.2

scale:

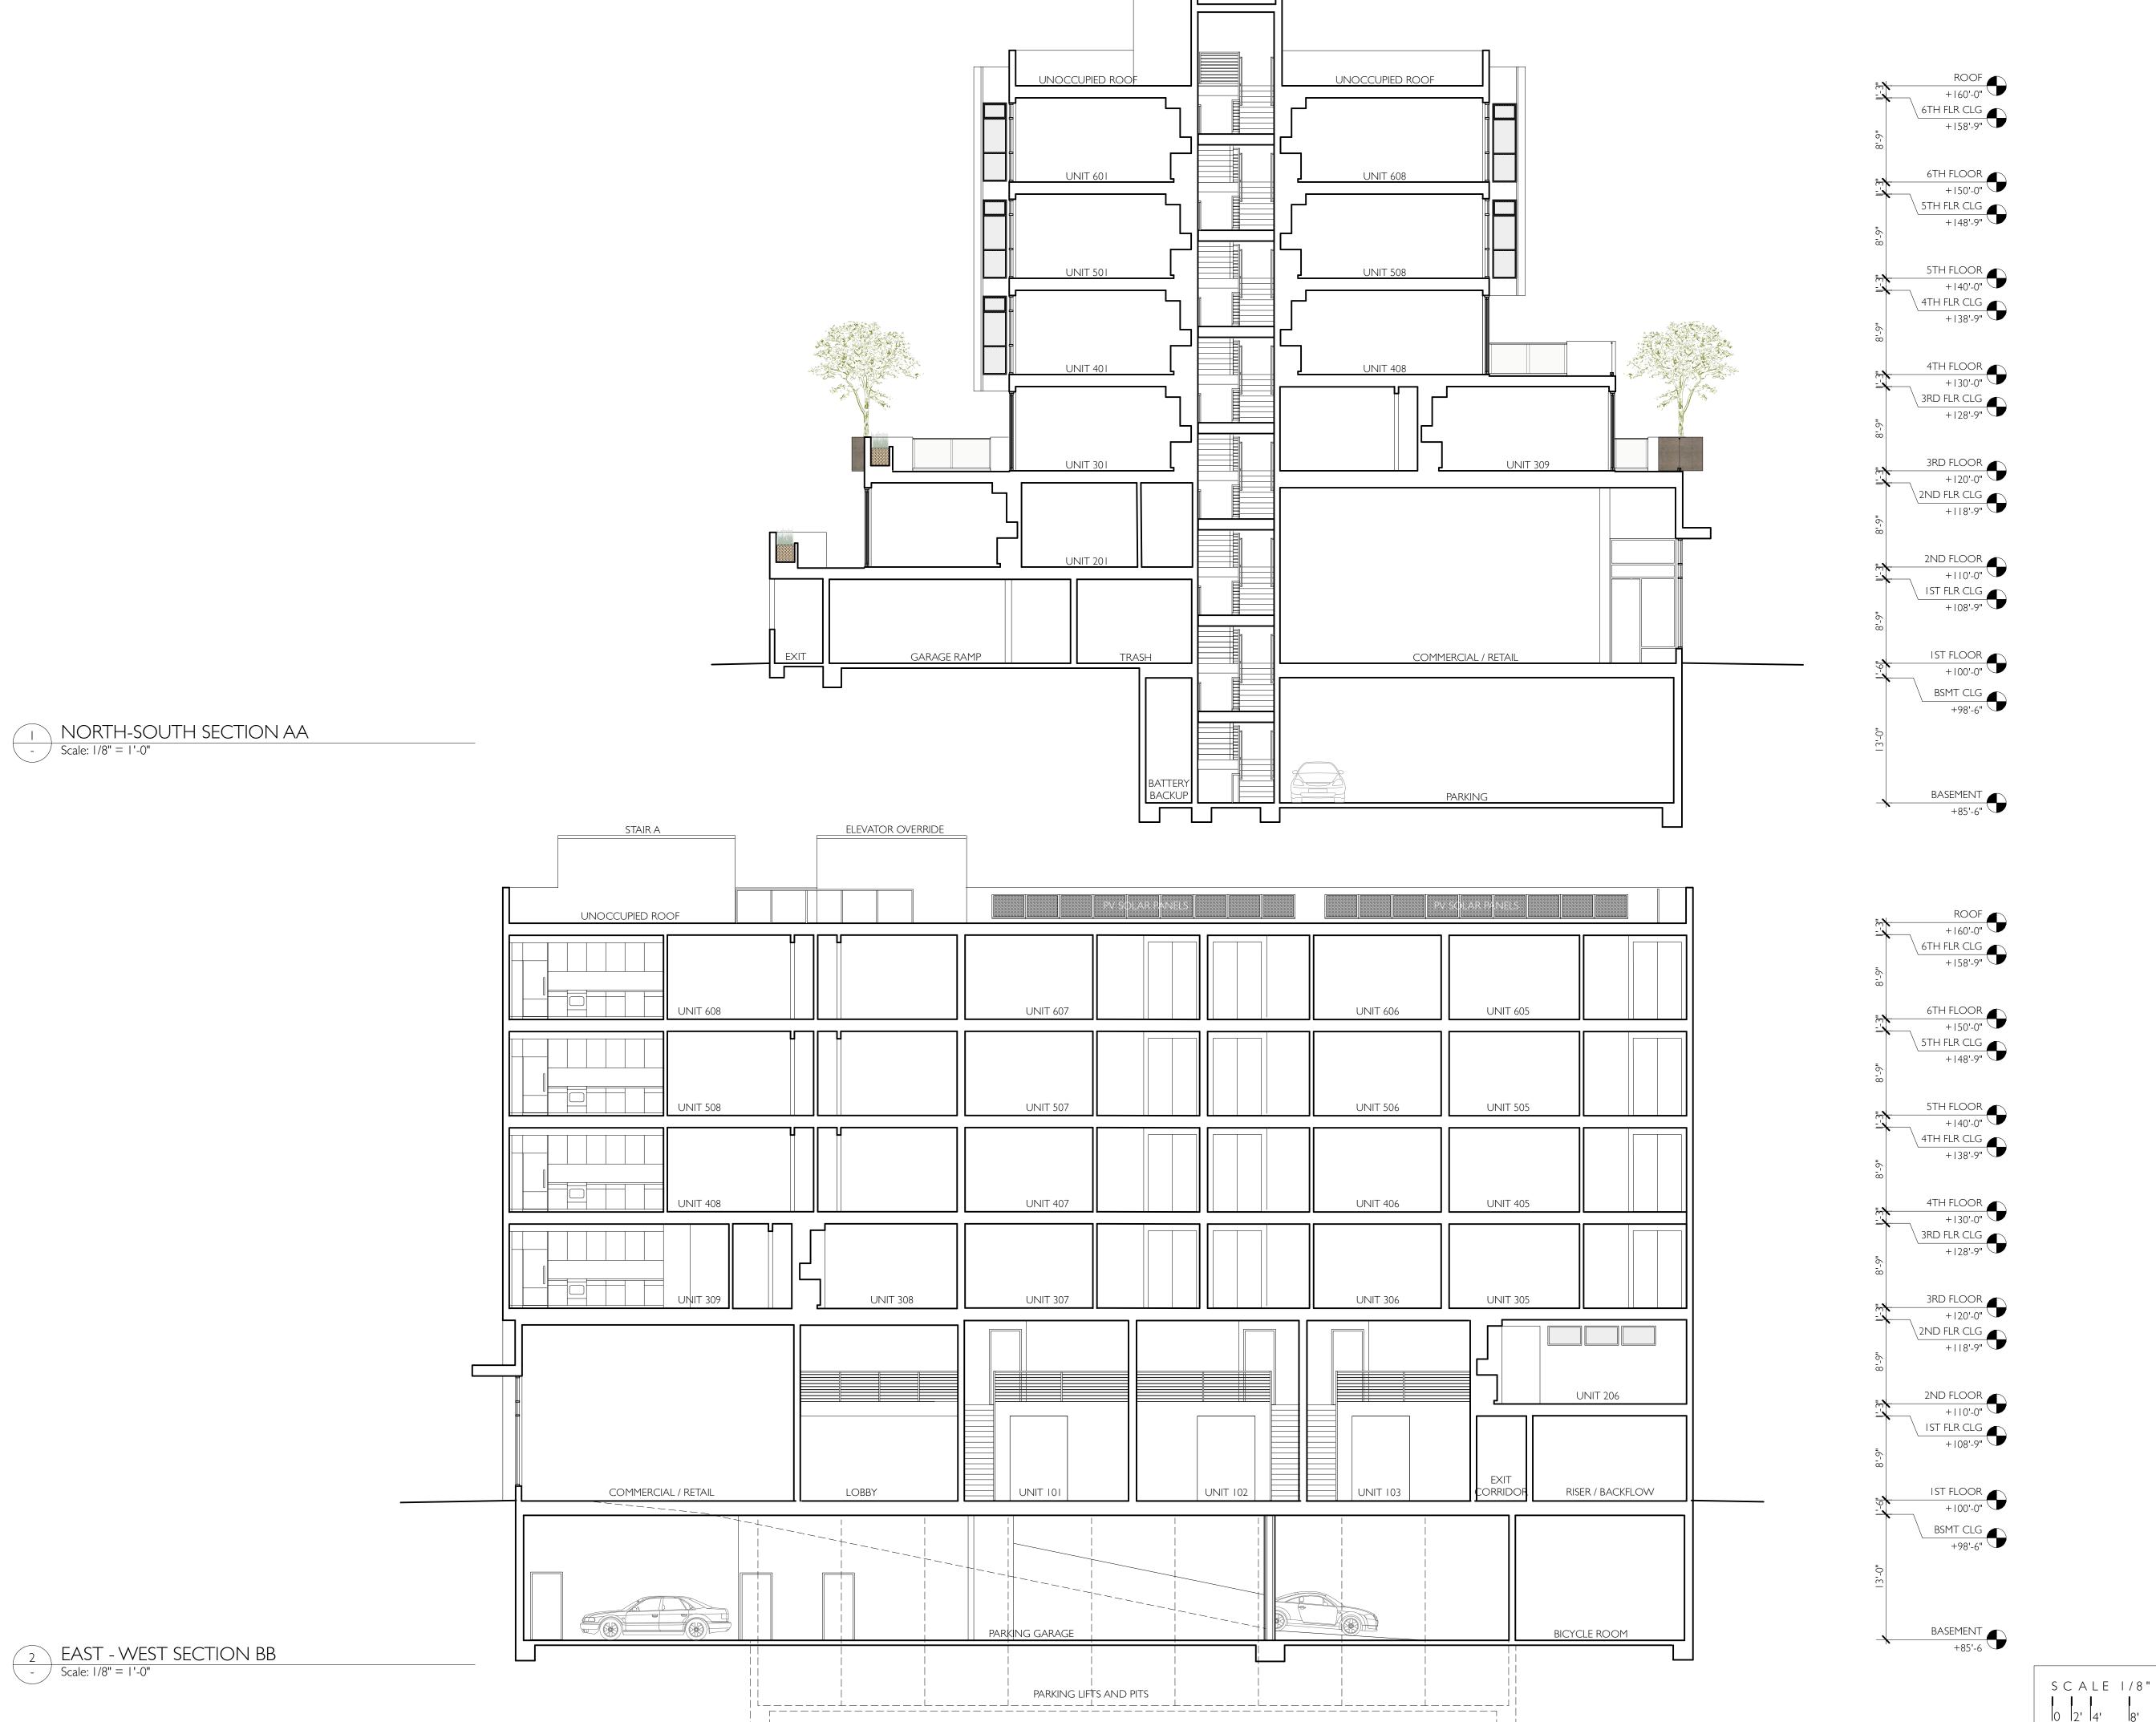



415.537.1125 (San Francisco) :v 707.433.2509 (Healdsburg) :v www.elevationarchitects.com :w

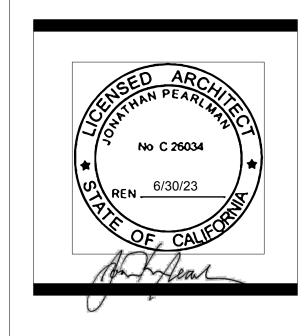

MIXED USE DEVELOPMENT
170 SAN BRUNO AVENUE
SAN BRUNO, CA 94066

#	date	issue	

Building Sections

project:	21.07
drawn by:	JP, KC
checked by:	JP
date:	4.26.22
scale:	

S C A L E 1/8" = 1'-0"
| 0 | 2' | 4' | 8' | 16'






ELEVATIONarchite

1159 Green Street, Suite 4 San Francisco, CA 94109 439 Healdsburg Avenue Healdsburg, CA 95448

415.537.1125 (San Francisco) :v 707.433.2509 (Healdsburg) :v www.elevationarchitects.com :w

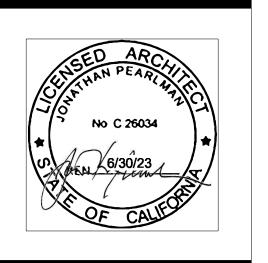

MIXED USE DEVELOPMENT 170 SAN BRUNO, CA 94066 SAN BRUNO, CA 94066

# date issue	
12.09.21 pre-applica	ation

3D Rendering

project:	21.07
drawn by:	JP, KC
checked by:	JP
date:	8.26.21
scale:	






ELEVATIONarchitects

1159 Green Street, Suite 4 San Francisco, CA 94109 439 Healdsburg Avenue Healdsburg, CA 95448

415.537.1125 (San Francisco) :v 707.433.2509 (Healdsburg) :v www.elevationarchitects.com :w

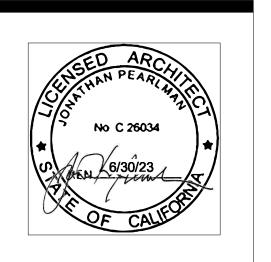

MIXED USE DEVELOPMENT 170 SAN BRUNO AVENUE SAN BRUNO, CA 94066

#	date	issue
12.09	9.21	pre-application

3D Rendering

project:	21.07
drawn by:	JP, KC
checked by:	JP
date:	8.26.21
scale:	






ELEVATIONarchitects

1159 Green Street, Suite 4 San Francisco, CA 94109 439 Healdsburg Avenue Healdsburg, CA 95448

415.537.1125 (San Francisco) :v 707.433.2509 (Healdsburg) :v www.elevationarchitects.com :w

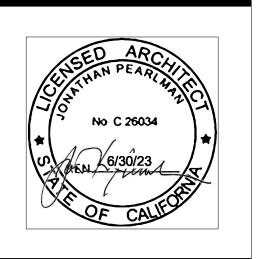

#	date	issue
12.09.21		pre-application

3D Rendering

JP, KC
Ji, NC
JF
8.26.21